

DRG. NO. TB-3-404-316-004

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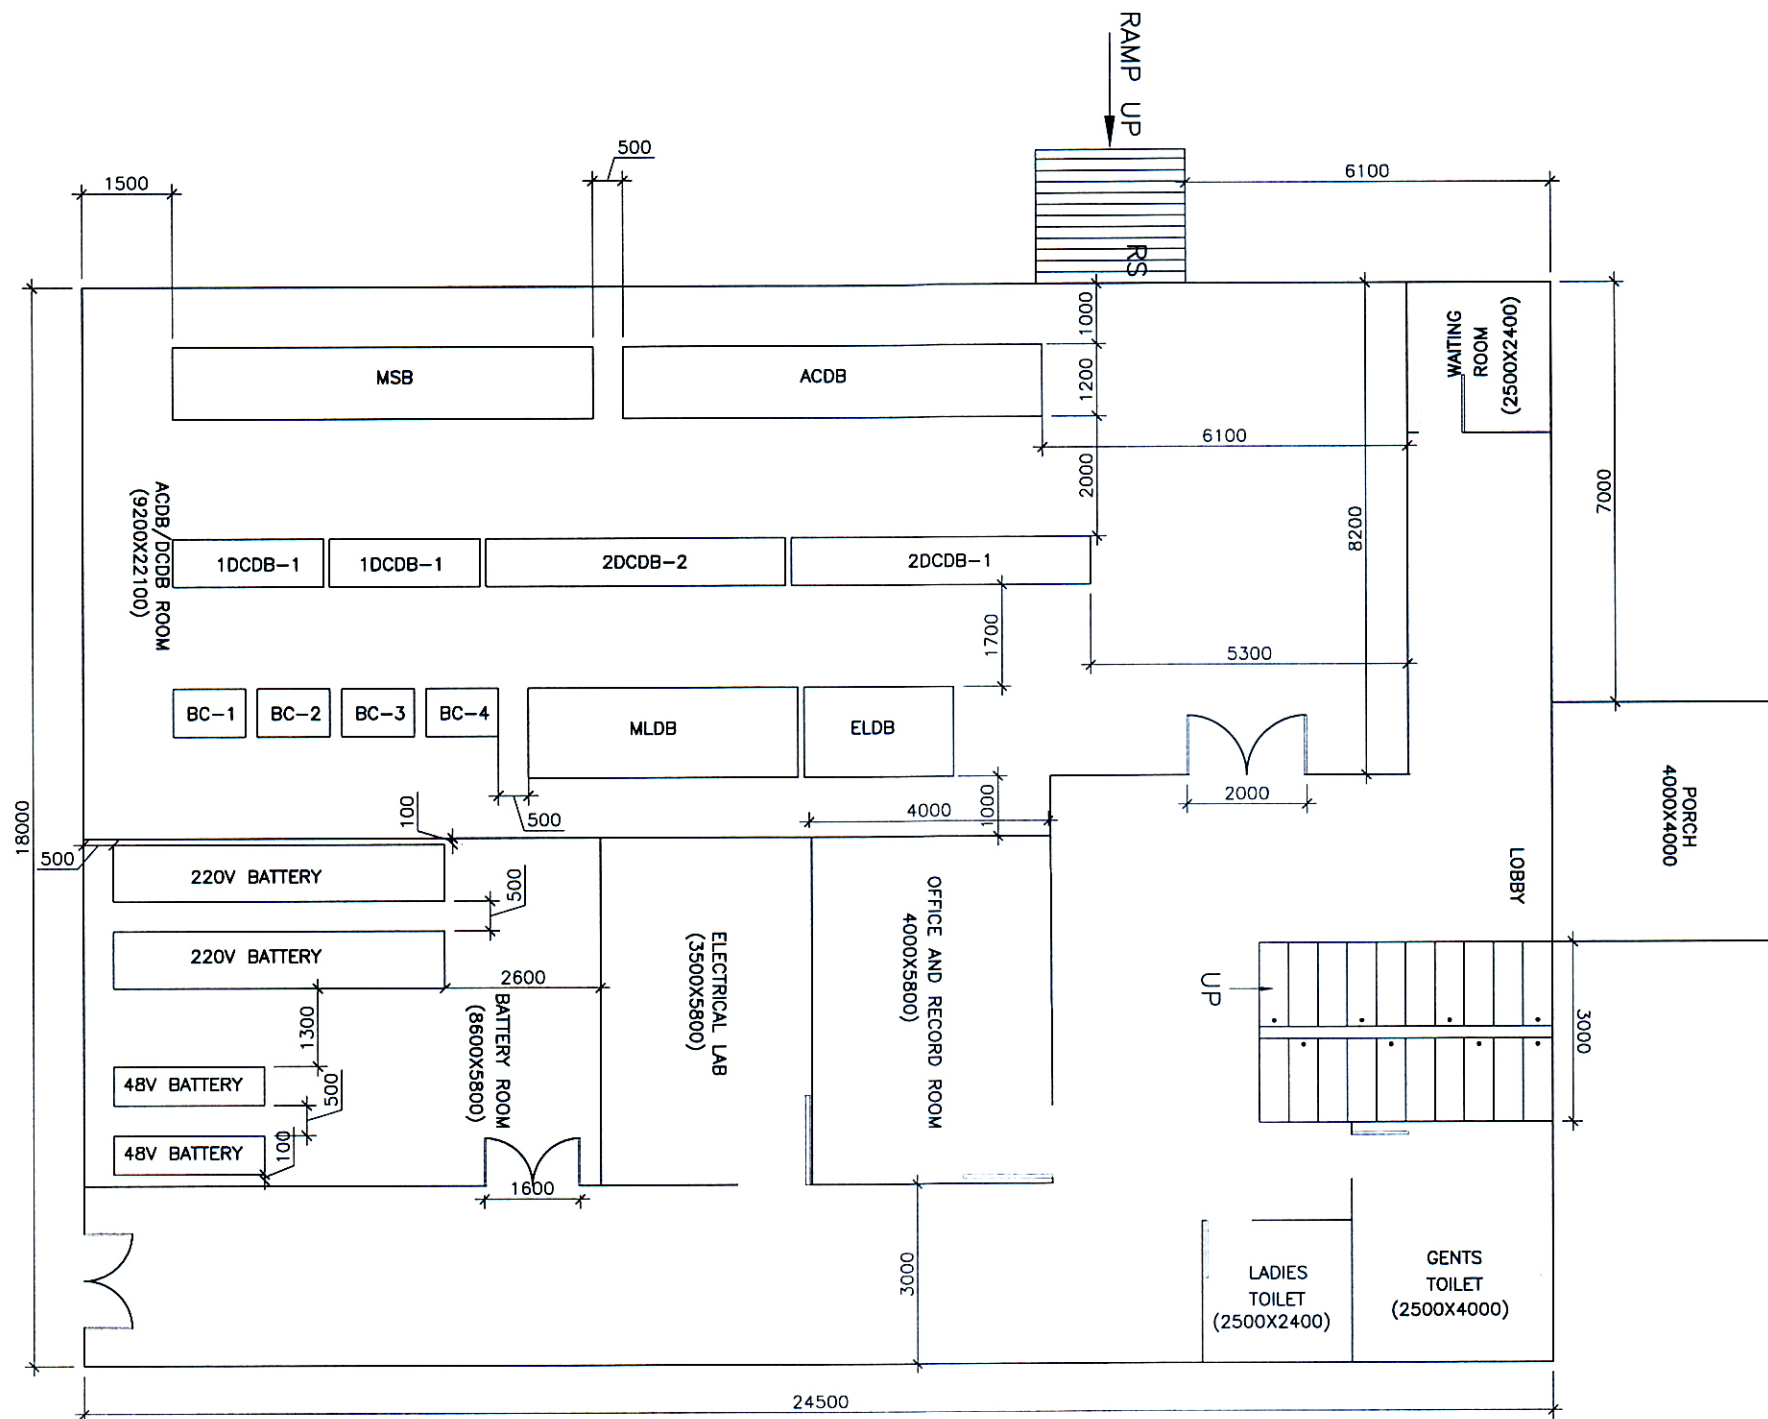
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Office of The Superintending Engineer  
Electricity 765/400KV Substation Design Circle  
UP Power Transmission Corporation Limited  
11th Floor, Shakti Bhawan Extn. Lucknow  
**APPROVED**

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## NOTES:

- ALL DIMENSIONS INDICATED ARE IN MM ONLY.
- EQUIPMENT/PANELS SIZE ARE TENTATIVE. FINAL SIZE SHALL BE AS PER APPROVED EQUIPMENT/PANELS DRAWINGS.

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## CONTROL ROOM BUILDING- GROUND FLOOR

REV.	DATE	ALTERED	REV.	DATE	ALTERED	REV.	DATE	ALTERED	REV.	DATE	ALTERED
		CHD/APPD			CHD/APPD			CHD/APPD			CHD/APPD
ZONE			ZONE			ZONE			ZONE		

REFERENCE: DRG. - TENDER SINGLE LINE DIAGRAM 400/220/132kV GIS S/S											
PROJECT: 400/220/132kV GIS SUBSTATION AT SHAMLI. (U.P.)											
CUSTOMER: UTTAR PRADESH TRANSMISSION CORPORATION LIMITED											
Bharat Heavy Electricals Ltd. Transmission Business Group Noida											
DEPT. TBG CODE			UNTOL. DIMS. GR. g/m/y			SCALE N.T.S			WEIGHT (KG) N.A.		
TITLE			CONCEPTUAL DRAWING FOR CONTROL ROOM- SHAMLI			CARD CODE NA			REF. TO ASSY. DRG. N.A.		
DRG. NO. TB-2-406-316-004			SHT. No 01			NO. OF SHT. 02			REV. 00		

